

Area Calculations:

1. This site plan is prepared under the Aggregate Resources Act (ARA) for a Class 'A' Licence, Category 2.

i. Licence Area (total) 76.9 ha South Extension 18.1 ha West Extension 58.8 ha

## B. References

1. Contours were obtained from the City of Burlington's Open Data Catalogue based on 2017 data and are displayed in one metre intervals. Elevations shown are in metres above sea level (masl).

2. Topographic information was obtained from numerous sources including Ontario GeoHub (Land Information Ontario), City of Burlington's Open Data Catalogue, Google Earth Pro aerial photography captured on May 7, 2018 and field investigations for technical reports.

3. All topographic features and structures are shown to scale in Universal Transverse Mercator (UTM) with North American Datum 1983 (NAD83), Zone 17 (metre), Central Meridian 81 degrees west coordinate system. 4. The licence boundaries were established using Municipal Property Assessment Corporation (MPAC) parcel fabric data. Distances are approximate and for reference purposes only.

5. Land use designations on and within 120 metres of the licences are from the Niagara Escarpment Plan, Map 3 -Regional Municipality of Halton, approved June 1, 2017. The Burlington Quarry Extension lands are designated

6. Land use information and structures identified on or within 120 metres of the licence boundaries were determined using Google Earth Pro aerial photography captured on May 7, 2018. C. Drainage

# 1. Surface drainage on and within 120 metres of the licence boundaries are by overland flow in the directions shown by

arrows on the plan view, or by infiltration. D. Groundwater

# 1. The established groundwater table varies between 264 masl to 273 masl in the South Extension and 263 masl to 265

masl in the West Extension (EarthFX 2020). E. Site Access and Fencing

1. There are four existing site accesses on Side Road No. 2 and a single existing site access on Cedar Springs Road. 2. Post and wire fencing (unless noted otherwise) exists in the locations shown on the plan view.

1. There are no existing aggregate operations or features on either Extension such as internal haul roads, processing, stockpiles, scrap, fuel storage, berms or excavation faces.

### G. Cross Sections 1. See drawing 4 of 4.

# H. Technical Reports - References

F. Aggregate Related Site Features

1. Adaptive Management Plan, Proposed Burlington Quarry Extension, EarthFX Inc., Savanta, and Tatham Engineering,

2. Agricultural Impact Assessment, Nelson Aggregate Co. Burlington Quarry Expansion, April 2020. 3. Air Quality Study for Nelson Aggregate Co., Burlington Quarry Extension, BCX Environmental Consulting, March 2020.

4. Archaeological Assessment (Stages 1, 2 & 3), Nelson Aggregates Quarry Expansion, Archaeologix Inc., August 2003. 5. Archaeological Assessment (Stage 4), Nelson Aggregates Quarry Expansion, Archaeologix Inc., August 2004. 6. Stage 1-2 Archaeological Assessment, Proposed West Extension of the Burlington Quarry, Golder Associates,

7. Blast Impact Analysis, Burlington Quarry Extension, Explotech Engineering Ltd, June 16, 2021.

8. Cultural Heritage Impact Assessment Report, Burlington Quarry Extension, MacNaughton Hermsen Britton Clarkson Planning Limited (MHBC), June 2021. 9. Financial Impact Study, Proposed Burlington Quarry Extension, Nelson Aggregates Co., September 30, 2021.

10. Level 1 and 2 Hydrogeological and Hydrological Impact Assessment Report, Proposed Burlington Quarry Extension, EarthFX Incorporated, April 2020.


11. Level 1 and 2 Natural Environment Technical Report, Proposed Burlington Quarry Extension, Savanta, April 2020. 12. Noise Impact Assessment, Nelson Aggregate Quarry Extension, Howe Gastmeier Chapnik Limited, November 15, 2021.


13. Nelson Aggregate Company, Burlington Quarry Extension Traffic Report, Paradigm Transportation Solutions Limited, February 2020.


14. Surface Water Assessment, Burlington Quarry Extension, Tatham Engineering, April 2020.

15. Visual Impact Assessment Report, Proposed Extension of the Burlington Quarry, MacNaughton Hermsen Britton Clarkson Planning Limited (MHBC), June 2021. 16. Safety Review of the Proposed Access Plan for a Proposed Quarry Extension, True North Safety Group, June 2021.

# Other Lands Owned by Licensee

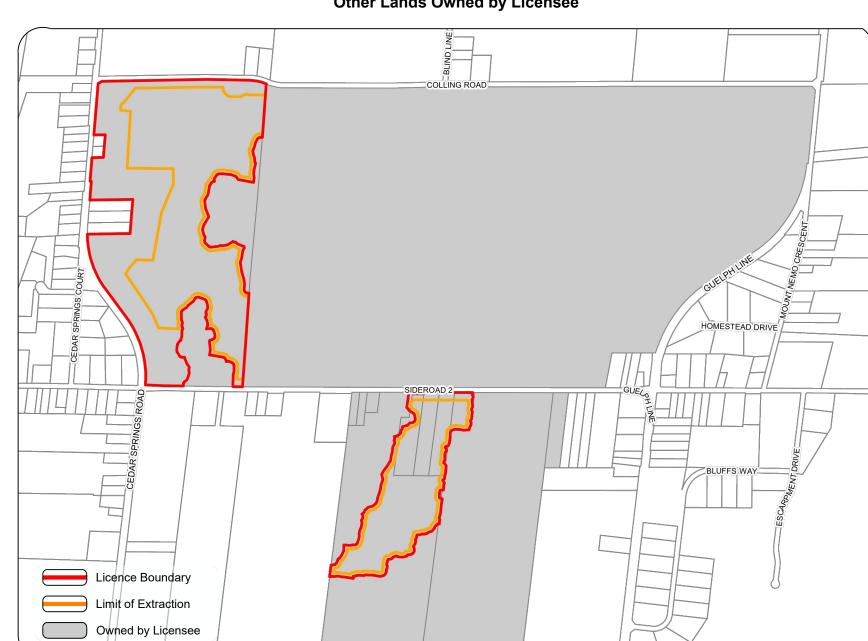

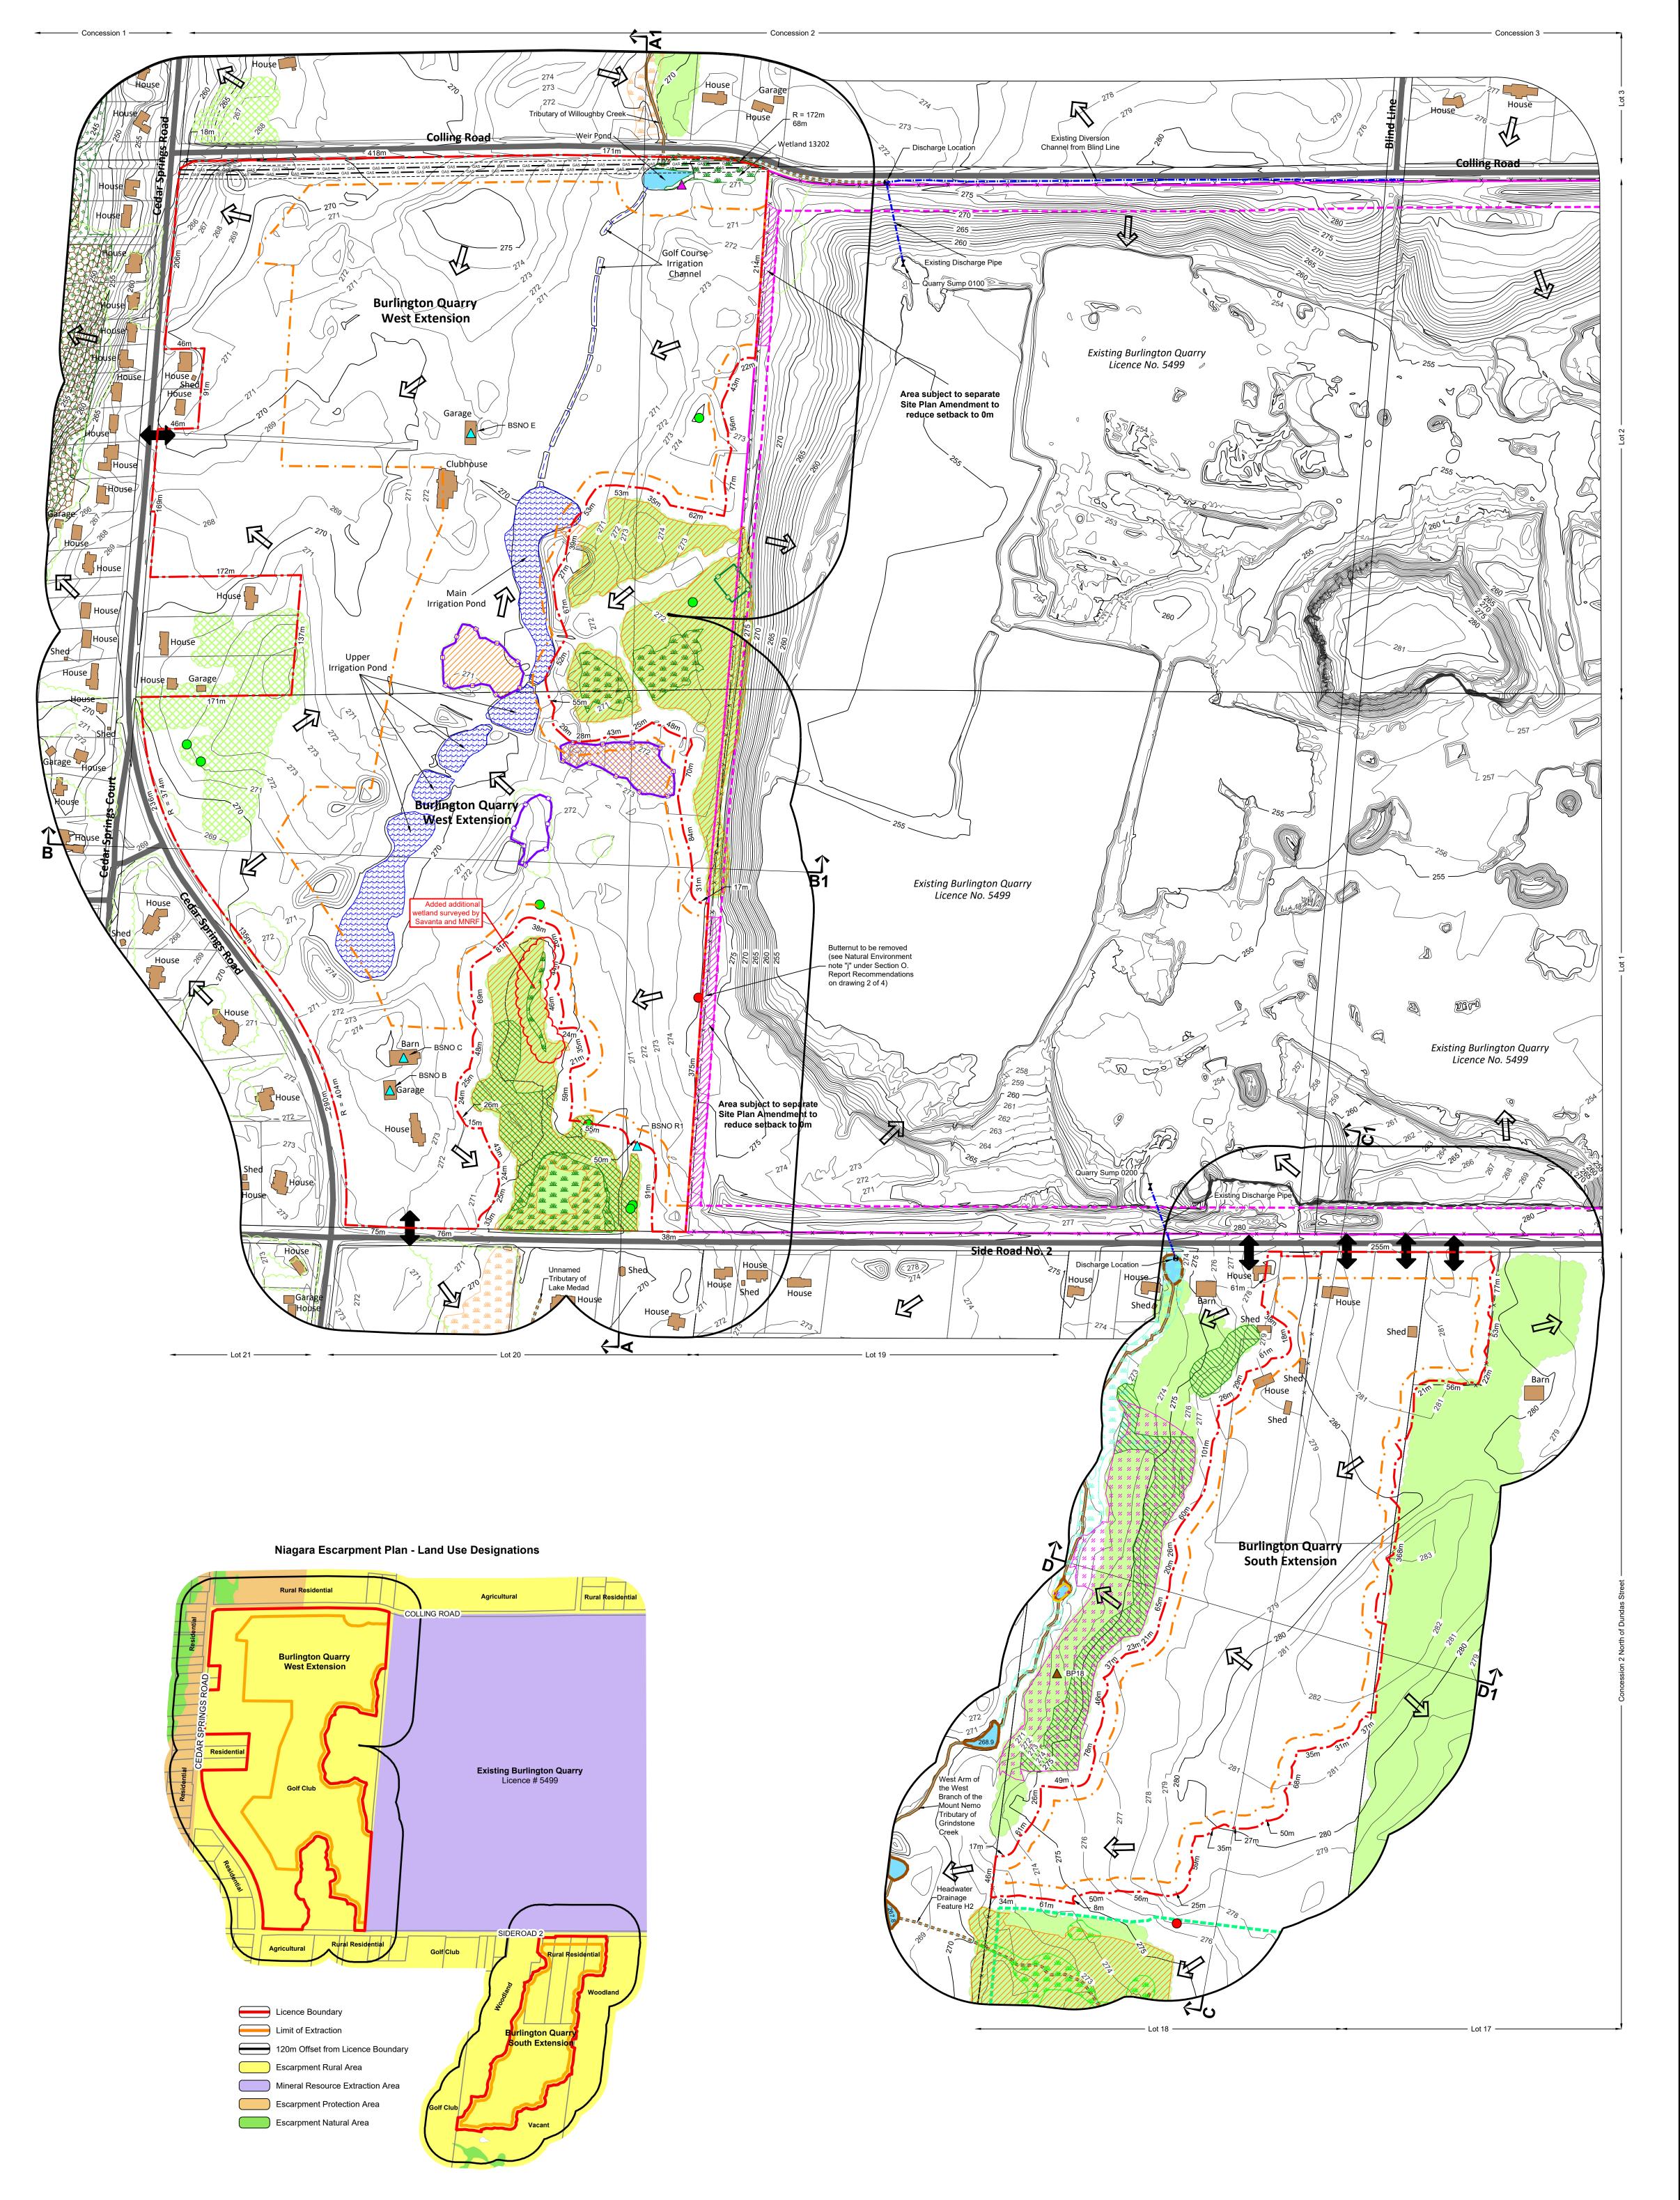

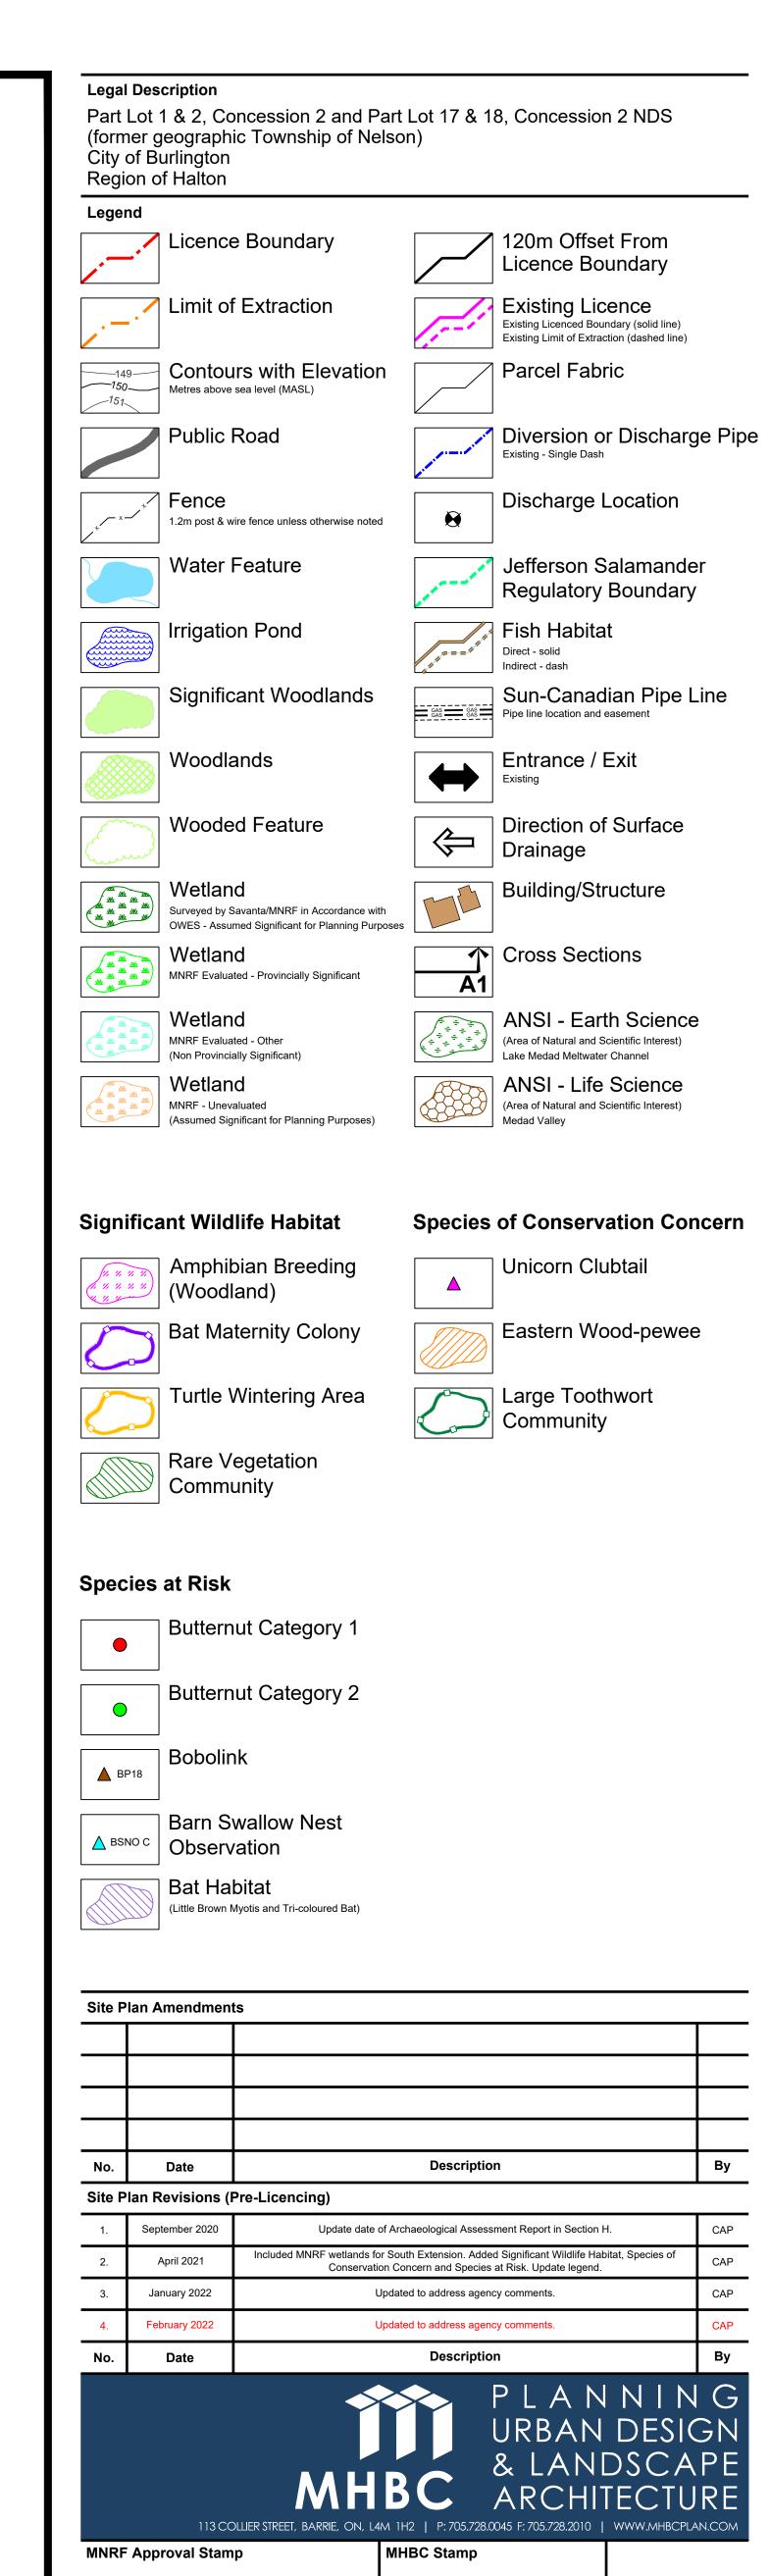




# Burlington Quarry Extension

MNRF Licence Reference No.			Pre-approval review:			
	626477					
Plan Scale: 1:3000 (Arch E)			Date February 2022			
0	100	200	Drawn By	C.P.	File No.	0405D
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Existing Licence

Parcel Fabric

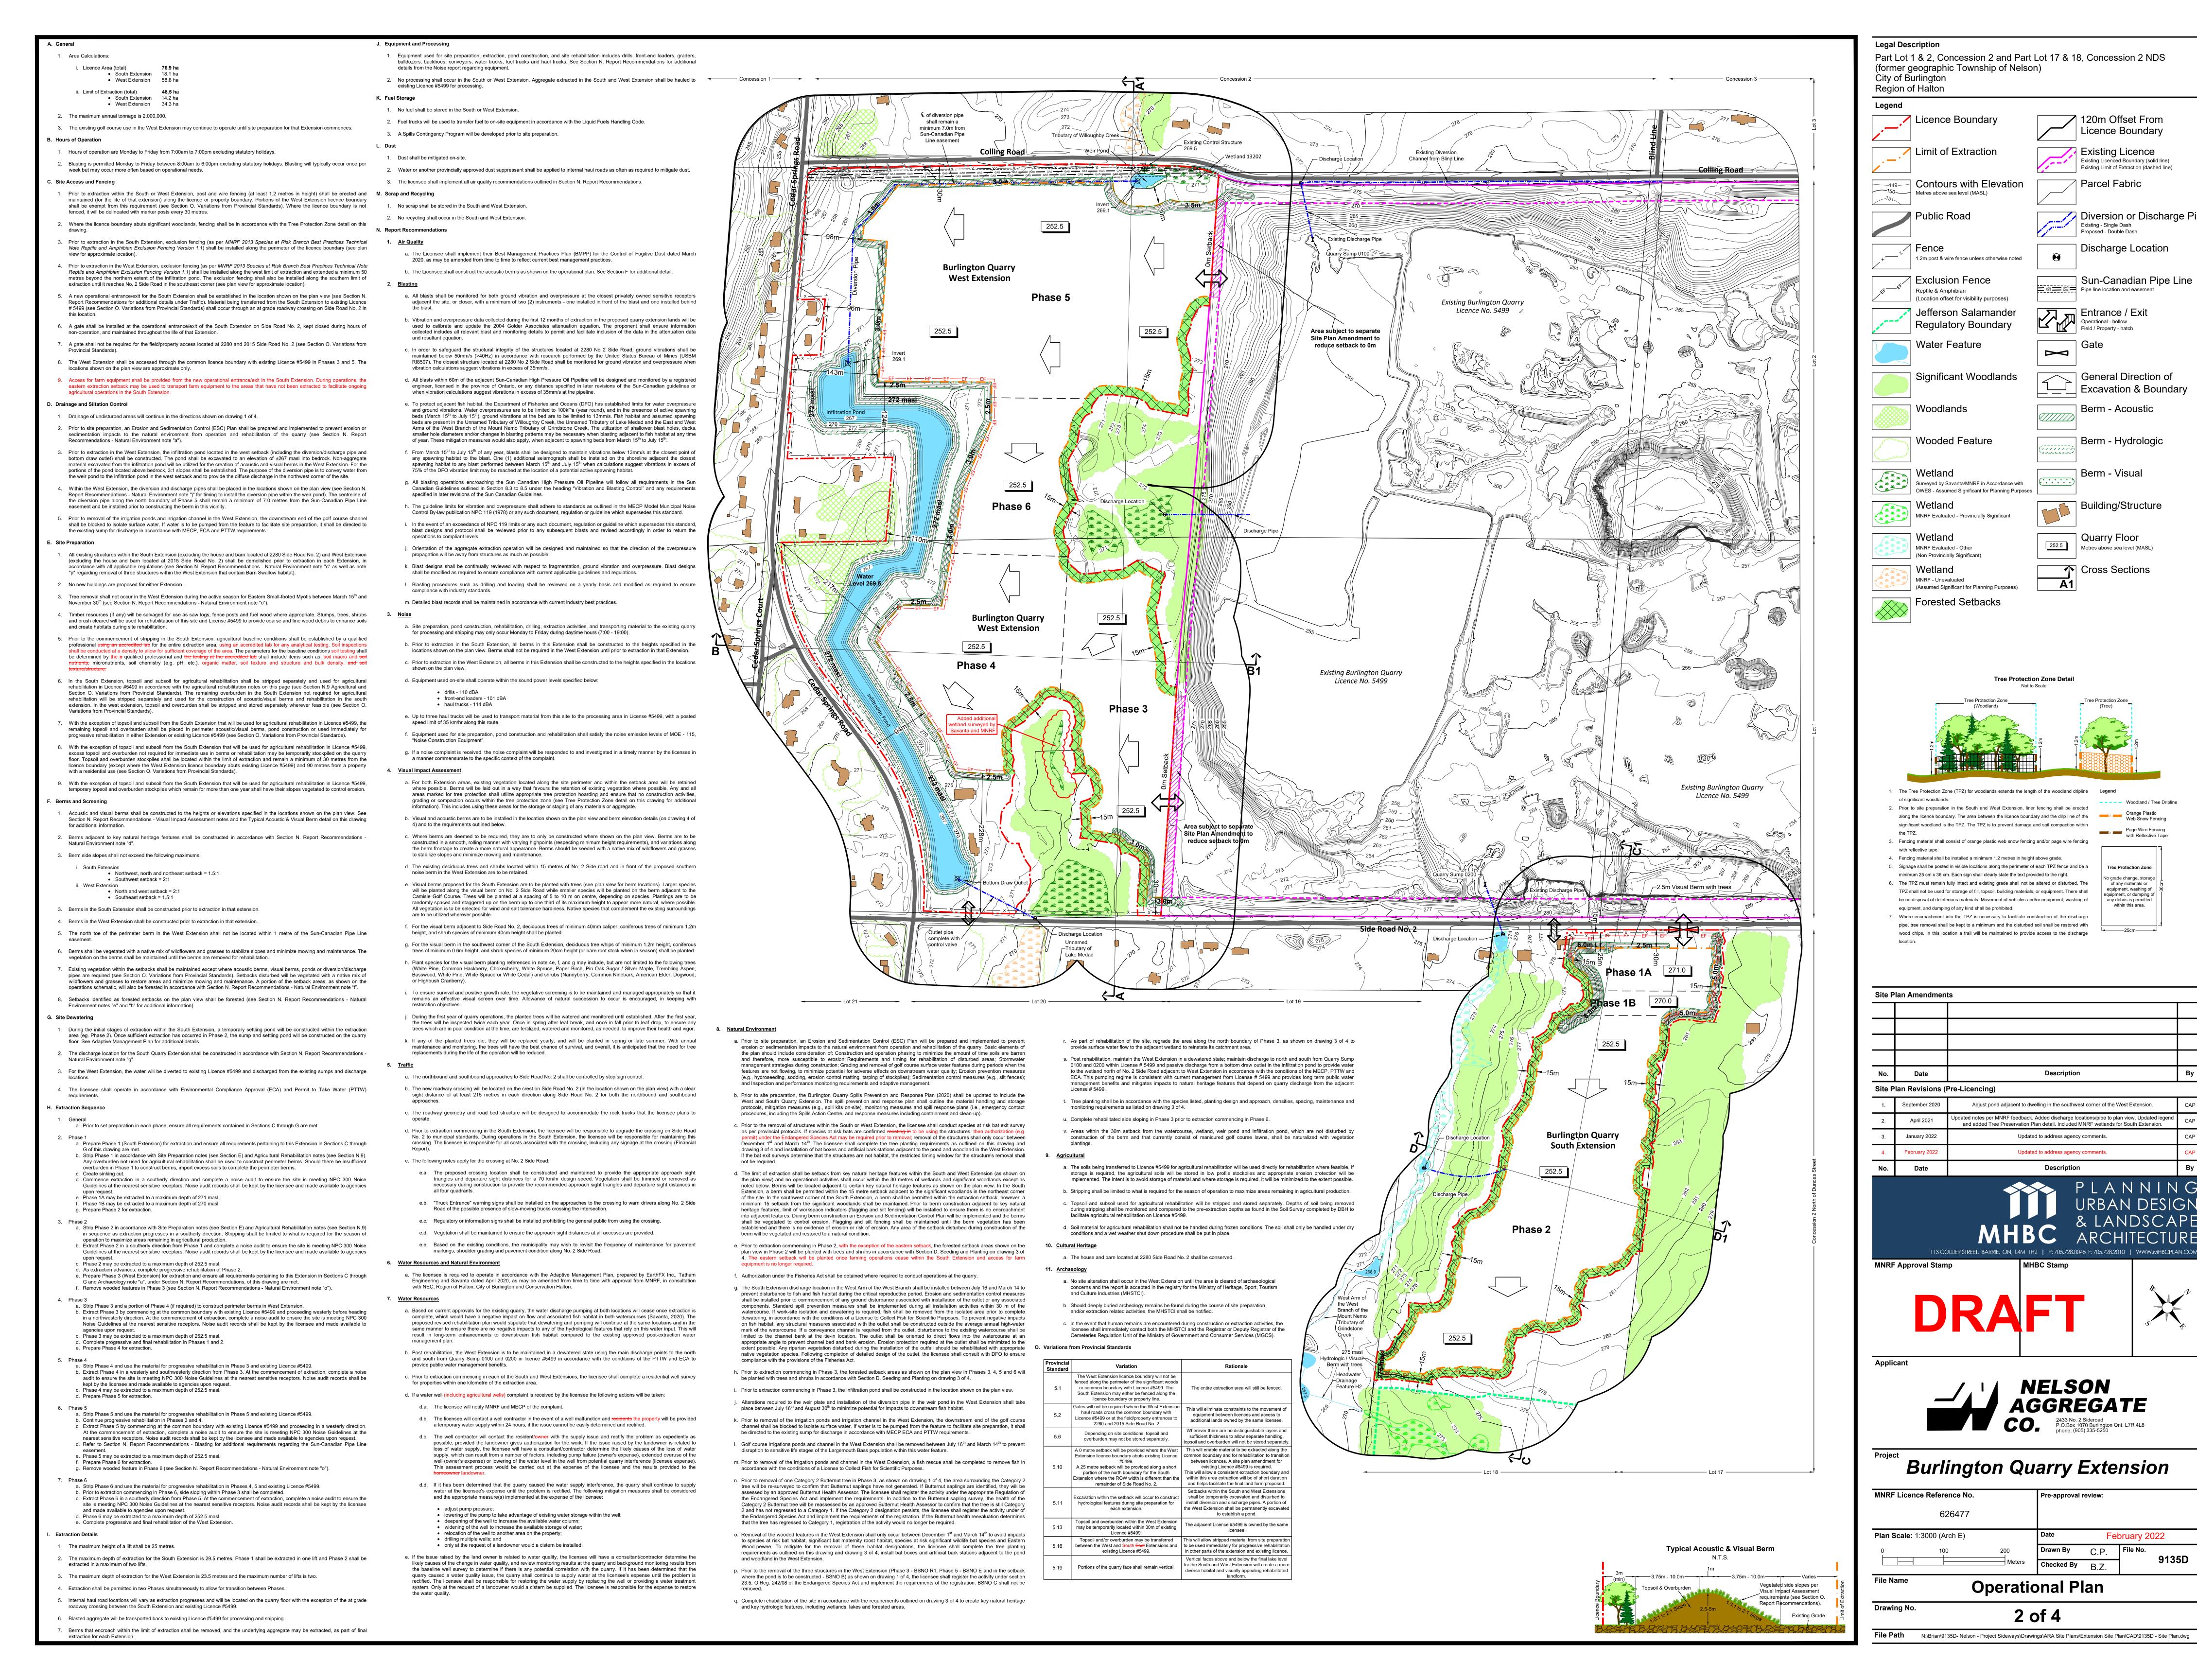Proposed - Double Dash

GAS GAS Pipe line location and easemen

Existing Licenced Boundary (solid line)

Existing Limit of Extraction (dashed line)

Discharge Location

General Direction o

Berm - Acoustic

Berm - Visual

Quarry Floor

Metres above sea level (MASL)

of any materials or

equipment, washing of

any debris is permitted

MHBC Stamp

Pre-approval review:

within this area.

Building/Structure

Excavation & Boundary

Diversion or Discharge Pipe

Sun-Canadian Pipe Line



provide waterfowl and turtle

loafing and bird perching and

overburden, rock and fill

Mav include lake

Quarry face partially backfilled

with overburden, rock and fill


Selective blasting will create irregular

cliff faces, shelves and ledges (with\_\_

pools on exposed vertical faces) at

and below the water level

3m North Extension 18m South Extension

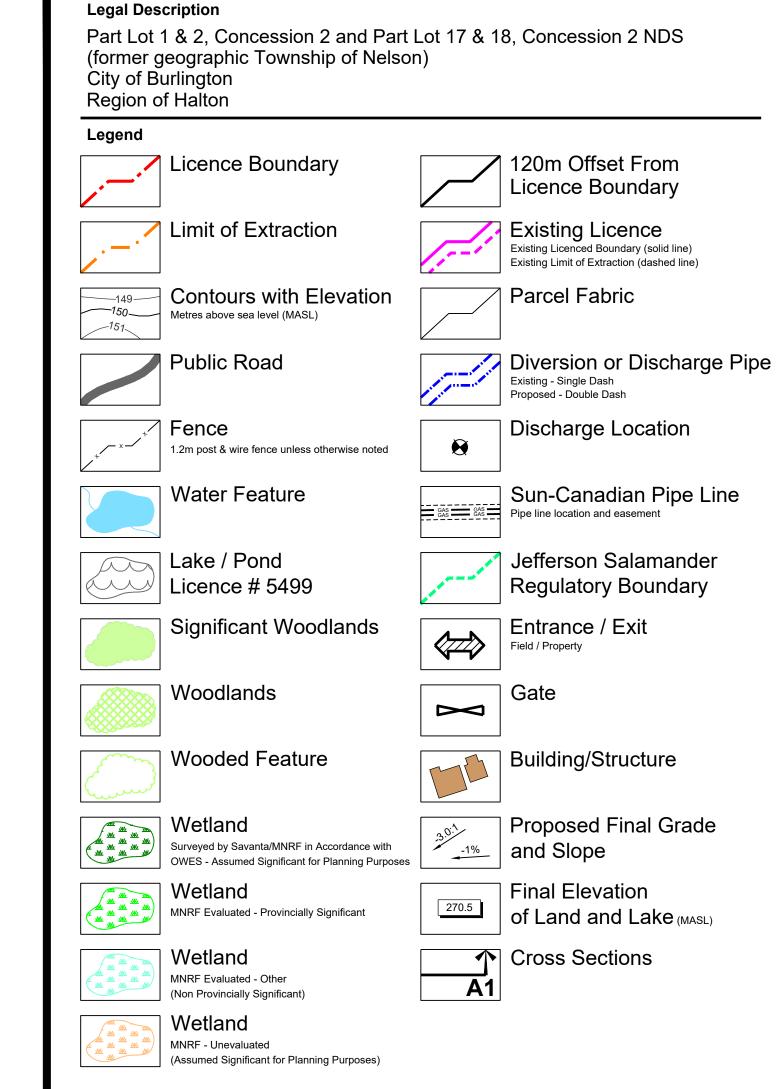









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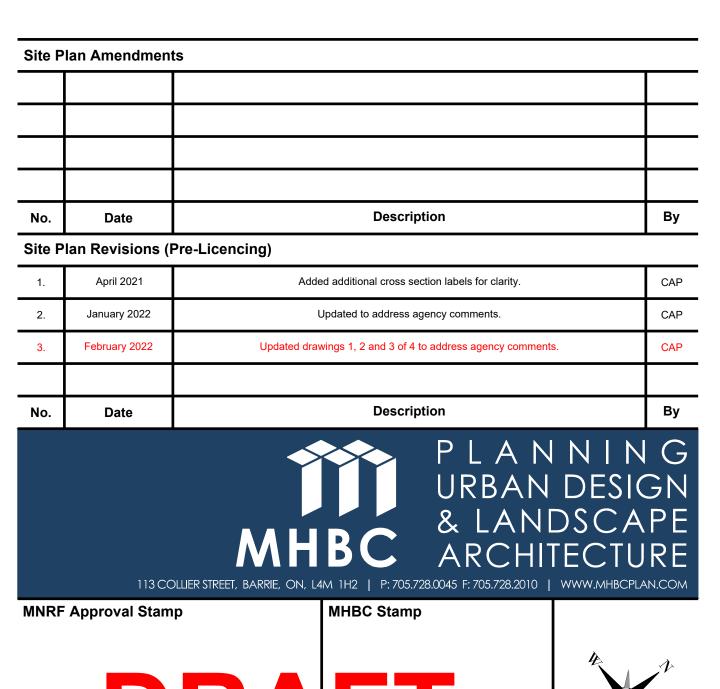
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NELSON
AGGREGATE
CO. 2433 No. 2 Sideroad
P.O.Box 1070 Burlington Ont. L7R 4L8
phone: (905) 335-5250

Burlington Quarry Extension

MNRF Licence Reference No.
626477

Plan Scale:
Horizontal 1:2000
Vertical 1:400

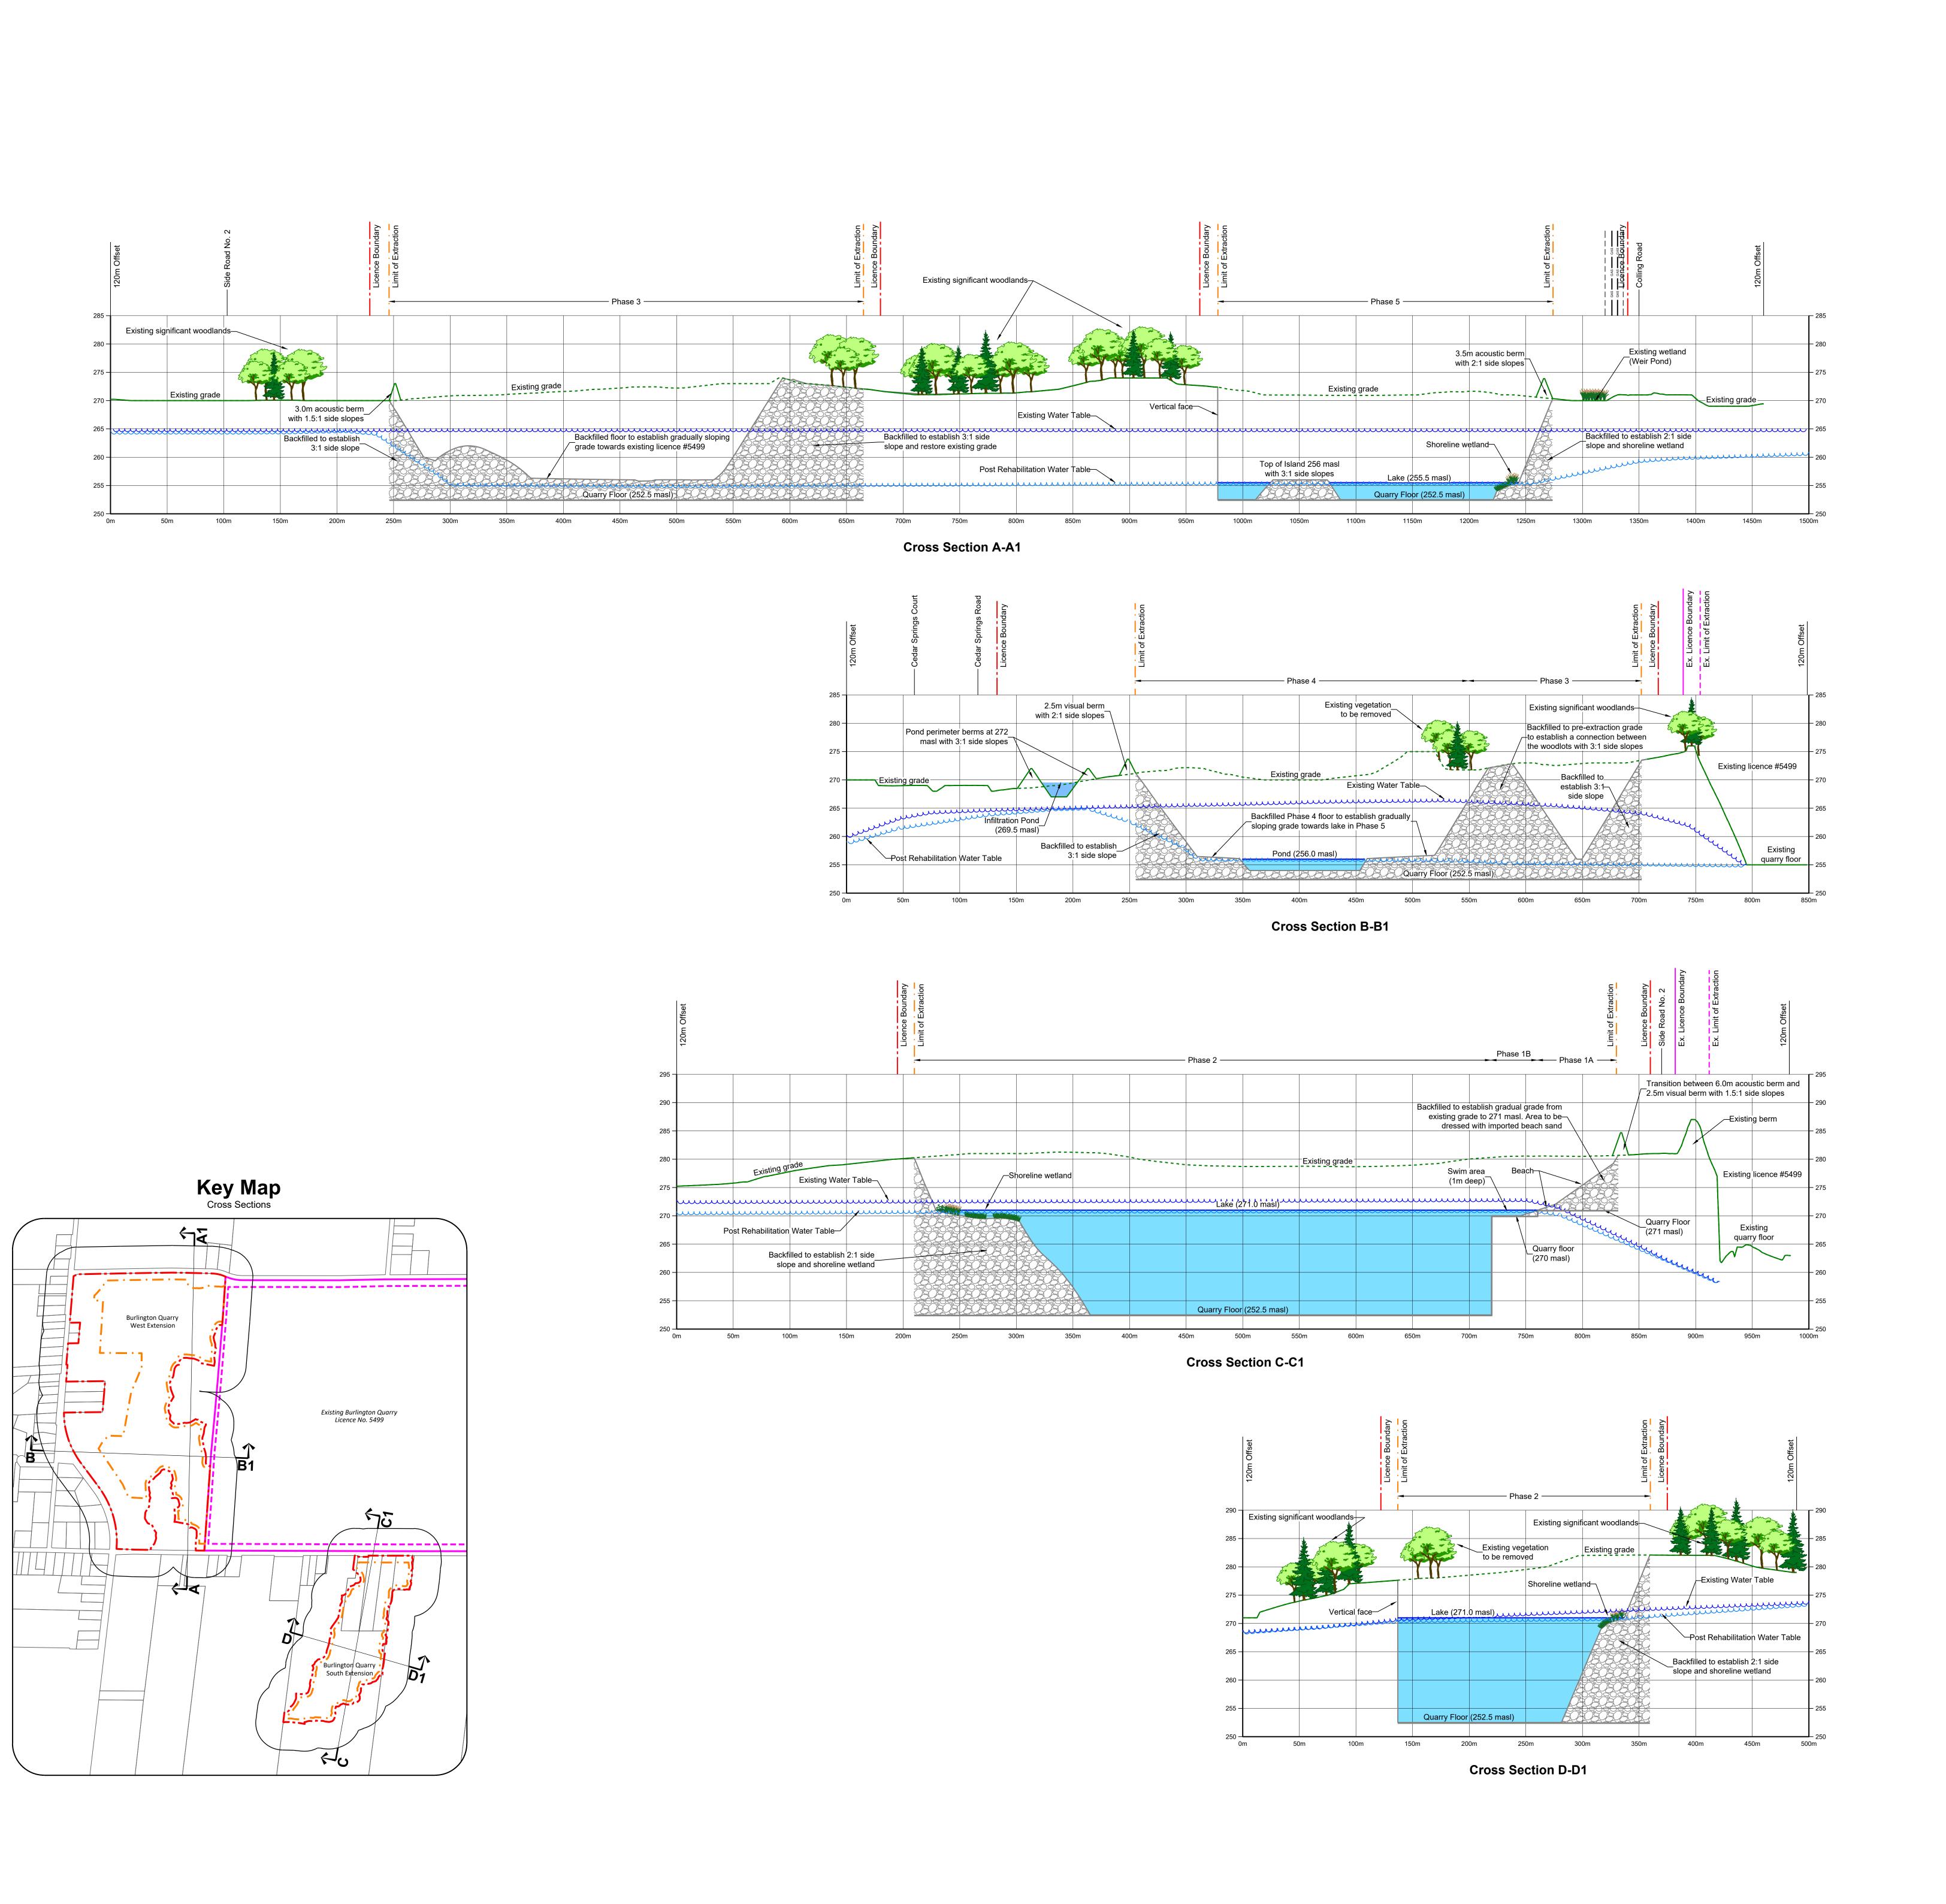Cross Sections

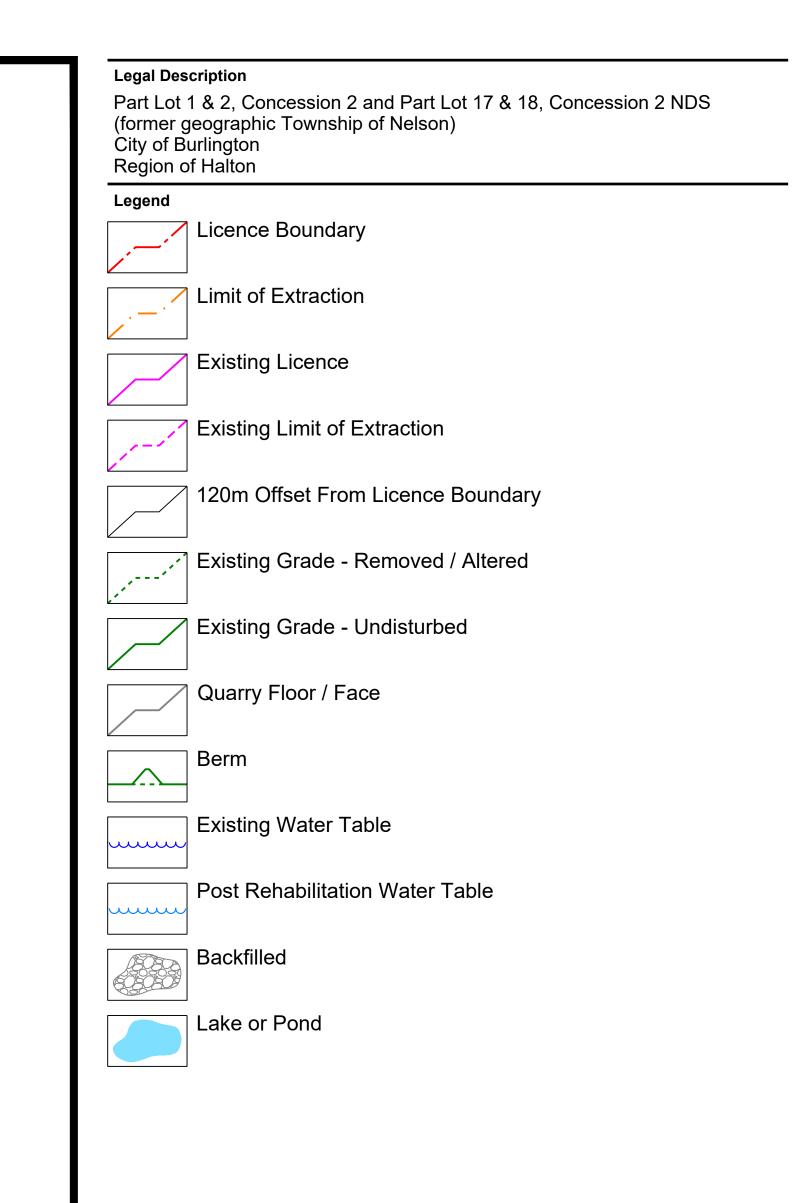Date February 2022

Drawn By C.P. File No.
9135D

Checked By B.Z.

Pre-approval review:

Checked By B.Z.

Pre-approval review:

Checked By B.Z.

Pre-approval review:

A of 4

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